


125 THICK R.C. SLAB,
SL81 MESH CENTRALLY
LOCATED. BROOM FINISH.
MIN. FALL TO STORMWATER
CATCHMENT

SLAB AND FOOTING PLAN
SCALE 1:50

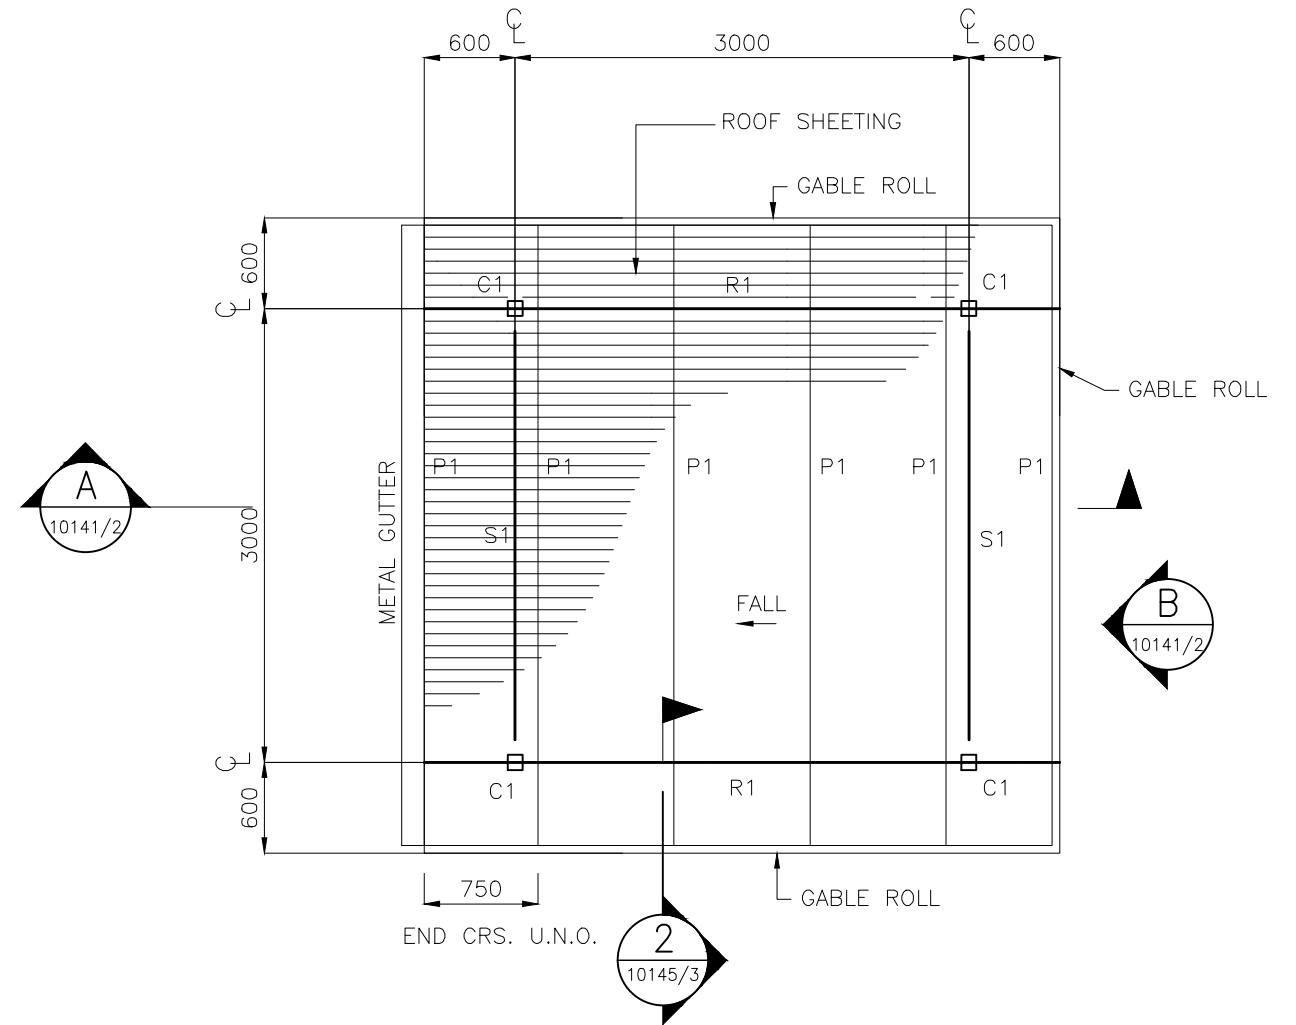

ROOF FRAMING PLAN
SCALE 1:50


GENERAL NOTES

1. REFER TO BSD-10145 SHEET 1 AND 2 FOR STRUCTURAL NOTES AND STEEL MEMBER SCHEDULE
2. REFER TO BSD-10145 SHEET 3 FOR TYPICAL FOOTING AND SLAB DETAILS.
3. REFER TO BSD-10145 SHEET 4 & 5 FOR SCREEN DETAILS IF SCREEN IS SPECIFIED FOR SHELTER.
4. (U) DENOTES UNDER

STRUCTURAL DESIGN CERTIFICATION		
DESIGN	DESIGN CHECK	AUTHORISED FOR ISSUE
Zhuangzhi Hu RPEQ:13885 2014.11.26 15:32:11+10'00'	D.Bateup RPEQ:13095 2014.11.26 16:07:50+10'00'	Bala Batakumar RPEQ 3963 2014.11.27 08:32:11 +10'00'

ISSUE	AMENDMENT	DRAWN DATE	CHK'D DATE	APPR'D DATE
B	Drawing Title Amended	FEB '16	JUL '16	JUL '16
A	ORIGINAL ISSUE	NOV '14	NOV '14	NOV '14

DRAWING AUTHORISED FOR PUBLICATION			
DESIGN	CPO - P&D	DATE	NOV '14
DRAWN	CPO - P&D	DATE	NOV '14
CHECKED	BI - FSG - AS	DATE	NOV '14
DRAWING FILENAME	BSD-10141 (B) Small Shelter - Natural area - Plan - Sheet 1 of 2.dwg		
ASSOCIATED PLANS	BSD-10141-Sheet 2		

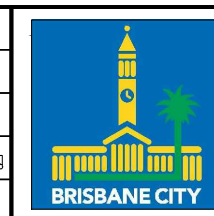

BRISBANE CITY COUNCIL STANDARD DRAWING	
<p>SMALL SHELTER NATURAL AREA - PLAN</p> <p>SHEET 1 OF 2</p>	<p>SCALE AS SHOWN</p> <p>DWG No. BSD-10141</p> <p>ORIGINAL SIZE A3 REVISION B</p>