



TOP ELEVATION

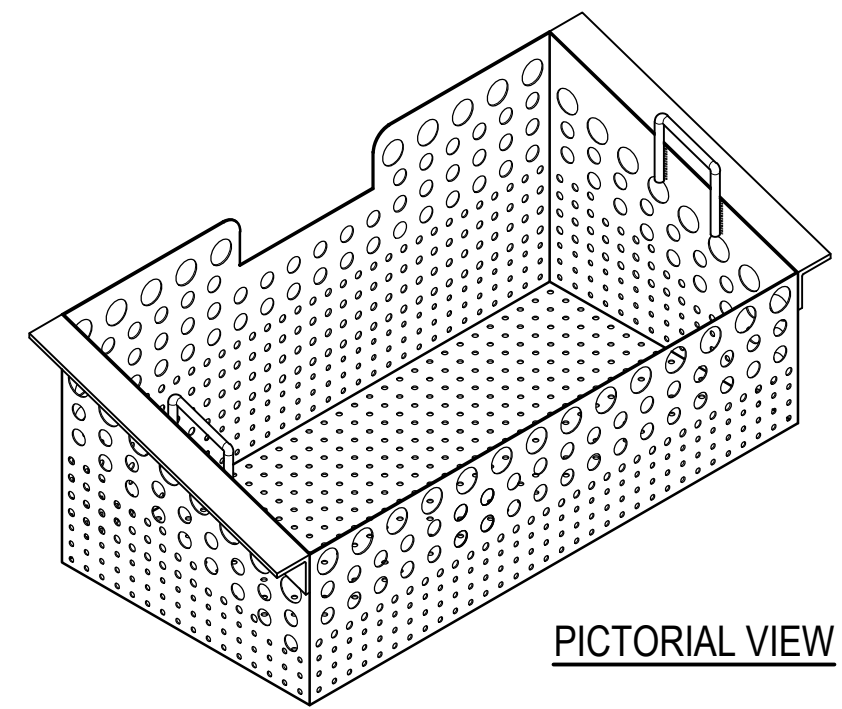

PICTORIAL VIEW

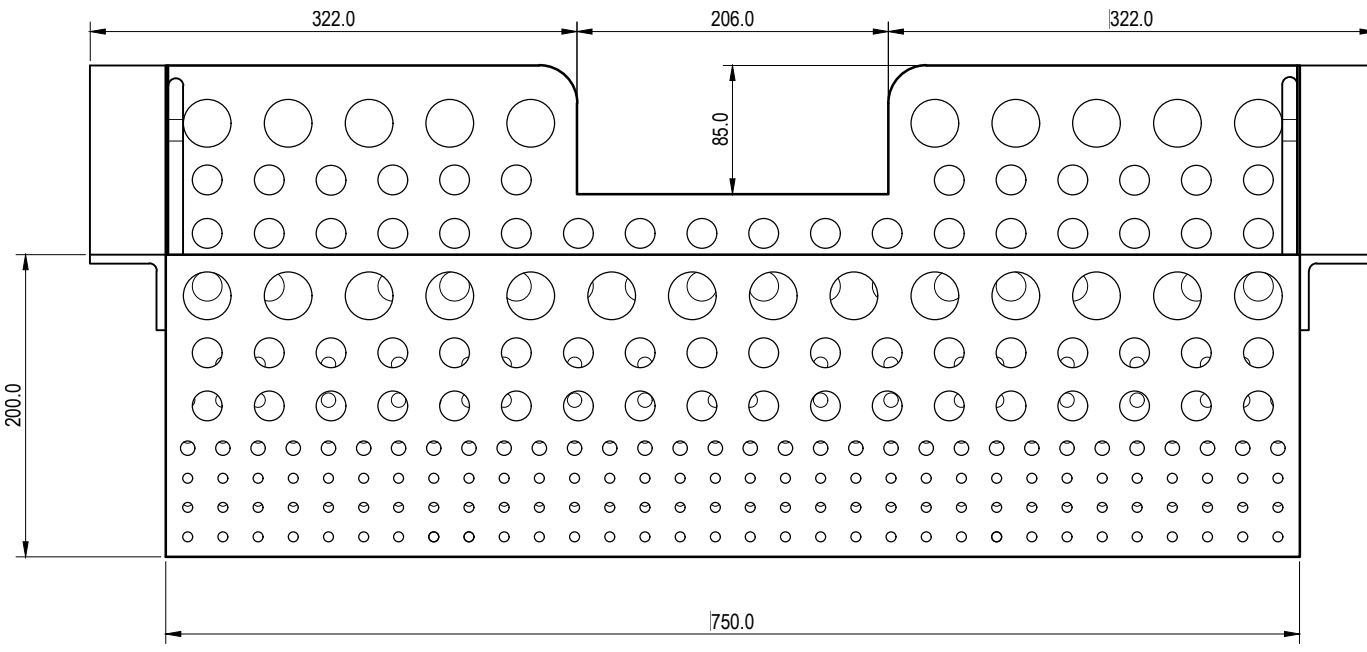

FRONT ELEVATION

SUPPORT BRACKET.
REFER SHEET 5

SUPPORT BRACKET.
REFER SHEET 5


HANDLE. REFER SHEET 5

SUPPORT BRACKET.
REFER SHEET 5

WELD HANDLE TO INSIDE OF
GULLY BASKET AROUND FULL
PERIMETER OF HANDLE.

WELD SUPPORT BRACKET TO OUTSIDE OF
GULLY BASKET ALONG TOP AND BOTTOM
OF BRACKET - MIN FOUR EQUALLY SPACED
WELDS. ENSURE TOP OF BRACKET IS
FLUSH WITH TOP OF BASKET.

WELD SIDES TOGETHER ALONG EDGES
INSIDE AND OUT.

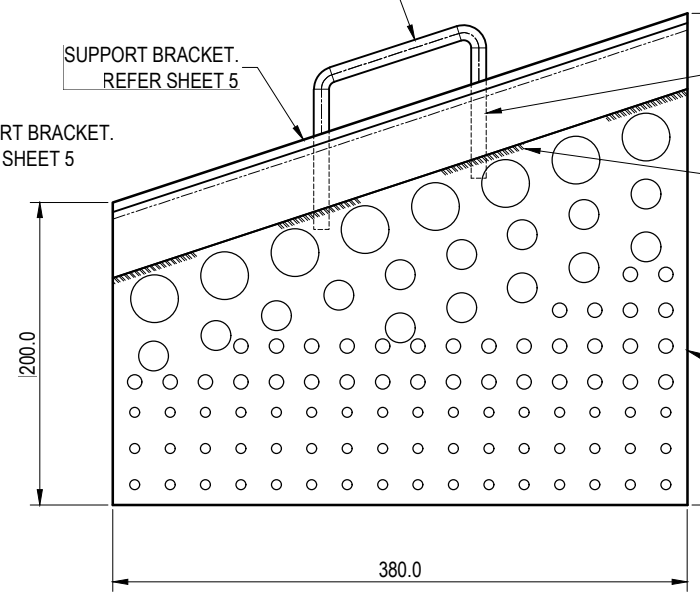


SIDE ELEVATION

NOTES:

1. MATERIAL:
 - BASKET BODY: 1.6mm PERFORATED STEEL. REFER SHEET 4.
 - BASKET SUPPORT BRACKETS: 50x6mm ANGLE. REFER SHEET 5.
 - HANDLES: Ø10 STEEL BAR BENT TO SHAPE. REFER SHEET 5.
2. HOT DIP GALVANISE MILD STEEL COMPONENTS (WHERE USED) TO AS/NZS4680 AFTER FABRICATION.
3. ALL WELDS TO BE 4mm CFW UNLESS NOTED OTHERWISE.
4. REFER SHEET 4 FOR HOLE SIZES AND SETOUT.
5. ALL DIMENSIONS IN MILLIMETRES (U.N.O.).

THE FITNESS FOR PURPOSE OF THIS STANDARD DRAWING FOR A SPECIFIC PROJECT SHALL BE ASSESSED AND ACCEPTED BY A SUITABLY QUALIFIED REGISTERED PROFESSIONAL ENGINEER OF QUEENSLAND (RPEQ).

	BRISBANE CITY COUNCIL STANDARD DRAWING		PUBLISH DATE AUG 2021	
	STEEL GULLY BASKET SIZE 2 (SMALL) BASKET ASSEMBLY SHEET 3 OF 6		SCALE NOT TO SCALE	
			DRAWING NUMBER BSD-8060	
			ORIGINAL SIZE A3	REVISION A